WALL 7.15R - TEMPORARY SOIL NAIL SHORING WSDOT I-405 RENTON TO BELLEVUE D/B

GENERAL NOTES:

- 1. ALL MATERIALS AND WORKMANSHIP SHALL BE IN ACCORDANCE WITH THE SPECIFICATIONS PROVIDED IN THE DOCUMENT M 41-10 2018 WASHINGTON STATE DEPARTMENT OF TRANSPORTATION STANDARD SPECIFICATIONS (AMMENDED 01-07-2019) FOR ROAD, BRIDGE AND MUNICIPAL CONSTRUCTION. WHERE CONFLICTS OCCUR, THE STANDARD SPECIFICATIONS SHALL PREVAIL.
- 2. THE SOIL NAIL WALL STRUCTURES HAVE BEEN DESIGNED IN ACCORDANCE WITH THE PROCEDURES CONTAINED
- a) WSDOT GEOTECHNICAL DESIGN MANUAL (GDM) M46-03.11 MAY 2015 AND ADDENDUM M46-03.12 REVISONS CHAPTERS 6 AND 15 b) WSDOT DESIGN MANUAL M22-01.18 DECEMBER 2019 AND M22-01.05 JUNE 2009
- c) FEDERAL HIGHWAY ADMINISTRATION (FHWA) PUBLICATION "SOIL NAIL WALL REFERENCE MANUAL ENGINEERING CIRCULAR NO. 7 (PUBLICATION NO. FHWA—NHI—14—007)
- REFERENCE MATERIALS:
- 1. "GEOTECHNICAL ENGINEERING REPORT, WALL 7.15R" PREPARED BY WOOD ENVIRONMENTAL AND DATED 10-01-2020
- 4. SOIL NAIL DESIGN PARAMETERS (PER REFERENCE 2 ABOVE):

SOIL/ROCK TYPE	FRICTION ANGLE (DEGREES)	COHESION (PSF)	UNIT WEIGHT (PCF)	SHORING SURCHARGE (PSF)	DESIGN LOAD TRANSFER (DLT) SOIL/GROUT BOND * (KIPS/FT)
ESU #1A (EMBANKMENT	FILL) 34	0	115	250	.85 2

- * TO BE FIELD VERIFIED BY VERIFICATION AND PROOF TESTING
- 5. THIS DESIGN ASSUMES THAT THE WORKMANSHIP EMPLOYED WILL BE OF THE HIGHEST QUALITY AND THAT THE CONTRACTOR WILL BE DIRECTLY RESPONSIBLE TO THE DESIGN ENGINEER. THEREFORE, THIS DESIGN IS ONLY VALID IF CONSTRUCTED BY DRILL TECH DRILLING & SHORING, INC.
- 6. THE DESIGN LIFE FOR THE TEMPORARY SOIL NAIL WALL IS 3-YEARS OR LESS, AS DEFINED PER GDM 15-7.3.3
- 7. A MONITORING PLAN WILL BE PROVIDED UNDER A SEPARATE COVER.
- 8. THERE WILL BE NO UNUSUAL HEAVY CONSTRUCTION EQUIPMENT (CRANES OR LARGE EQUIPMENT) OR MATERIAL LOADS ABOVE THE TEMPORARY SOIL NAIL WALL. PER GDM 15-4.9 "SURCHARGE LOADS" AND GDM 15-7.3.3, THE REQUIRED SURCHARGE LOADING OF 250 PSF LIVE LOAD WAS INCLUDED IN THE DESIGN TO ACCOUNT FOR THE EXISTING TRAFFIC LOADS AND "ROUTINE CONSTRUCTION EQUIPMENT". THEREFORE, THE WALL CANNOT BE LOADED ABOVE STANDARD HIGHWAY LOADING.
- 9. TO THE BEST OF THE DESIGNERS KNOWLEDGE AT THIS TIME BASED ON THE SCOPE OF WORK, THE TEMPORARY SHORING SYSTEM (SOIL NAIL WALL) WILL NOT INTERFERE WITH FUTURE CONSTRUCTION FOR THIS PROJECT, WILL NOT IMPEDED THE FLOW OF GROUNDWATER, CREATE A HARD SPOT, OR CREATE A SURFACE OF WEAKNESS REGARDING SLOPE STABILITY.

EXCAVATION NOTES:

- 1. EXCAVATION SHOULD BE PERFORMED TO THE LINES AND GRADES SHOWN ON THE PROJECT GRADING PLANS.
- 2. MAX VERTICAL CUT FOR SOIL NAIL LIFTS SHALL NOT EXCEED 6'

SOIL NAIL NOTES:

- 1. NAIL GROUT: f'c = 4,000 PSI MIN. PER SECTION 9-20.3(4) WSDOT 2018 SPECIFICATIONS
- 2. NAIL BARS: BARE BAR GRADE 75 #7 ALL-THREAD BARS (ASTM A615)
- 3. LAYOUT OF SOIL NAILS IS AS SHOWN. ADJUSTMENTS MAY BE MADE PER WSDOT SECTION 6-15.3(6) TO ACCOMMODATE FIELD CONDITIONS AS APPROVED BY THE ENGINEER. ADJUSTMENTS OF UP TO 6 INCHES ON ISOLATED NAILS MAY BE MADE WITHOUT NOTIFYING THE ENGINEER. NAIL INCLINATION MAY BE CHANGED IN THE FIELD UP TO 3 DEGREES. LAYOUT LINES ARE BASED ON THE REFERENCED GRADING PLAN.
- 4. SPACING OF SOIL NAILS SHALL NOT BE CLOSER THAN 3 FEET IN ANY DIRECTION, SPACING OF SOIL NAILS SHALL NOT BE GREATER THAN 8 FEET IN VERY DENSE GLACIALLY OVER CONSOLIDATED SOILS, OR 6 FEET FOR OTHER SOIL TYPES IN THE HORIZONTAL AND VERTICAL DIRECTION.
- 5. DRILLING FOR SOIL NAILS SHALL NOT COMMENCE UNTIL ALL EXISTING UTILITIES IN THE SOIL NAIL ZONE HAVE BEEN LOCATED AND POTENTIAL CONFLICTS RESOLVED.
- 6. NAILS IN A GIVEN VERTICAL SECTION SHALL BE INSTALLED ACCORDING TO THE TYPICAL SECTION, DESIGN SCHEDULE, AND THE REFERENCED DETAILS.
- 7. ALL TEST NAILS ARE SACRIFICAL. TOTAL LENGTH OF THE TEST SOIL NAIL ASSEMBLY EQUALS EMBEDMENT LENGTH PLUS EXTRA LENGTH REQUIRED FOR JACKING EQUIPMENT.

SHOTCRETE NOTES:

- 1. REINFORCED SHOTCRETE: fy = 60,000 PSI (REBAR PER AASHTO M3I/ ASTM A706) PER WSDOT 9-07.2 fy = 60,000 PSI MIN PER WSDOT 9-07.7 f'c = 4,000 PSI (28-DAY SHOTCRETE COMPRESSIVE STRENGTH) PER WSDOT SECTION 6-18
- 2. CEMENT AMD AGGREGATE FOR SHOTCRETE SHALL CONFORM WSDOT SECTION 6-18.2
- 3. SHOTCRETE TESTING AND TEST PANEL REQUIREMENTS SHALL BE PER WSDOT SECTION 6-18.3(3)
- 4. MINIMUM LAP SPLICE OF STEEL REINFORCEMENT SHALL BE AS FOLLOWS: REBAR: 48 BAR DIAMETERS WWF: 2 SQUARES
- 5. GEOCOMPOSITE DRAIN BOARDS SHALL BE SECURED TO THE SLOPE/BACKFORM IN SUCH A MANNER THAT PREVENTS SHOTCRETE FROM GETTING BETWEEN THE CUT SLOPE/BACKFILL AND THE GEOCOMPOSITE DRAIN.
- 6. GEOCOMPOSITRE DRAIN SHALL BE PER WSDOT SECTION 9-33.2(3).

SOIL NAIL TESTING:

1. ALL SOIL NAIL VERIFICATON AND PROOF TESTING SHALL BE IN ACCORDANCE WITH THE SPECIFICATIONS PROVIDED IN THE DOCUMENT M 41-10 2018 WASHINGTON STATE DEPARTMENT OF TRANSPORTATION STANDARD SPECIFICATIONS (AMMENDED 01-07-2019) FOR ROAD, BRIDGE AND MUNICIPAL CONSTRUCTION. IN PARTICULAR SECTION 6-15.3(8).

CONSTRUCTION SEQUENCE:

- 1. FOR SHOTCRETE METHODS AND EQUIPMENT, REFER TO FLJV SUBMITTAL 0470
- 2. FOR SOIL NAIL WALL CONSTRUCTION PROCEDURES, REFER TO FLJV SUBMITTAL 0477

TEST PIT EXPLORATION:

1. PRIOR TO CONSTRUCTION OF THE SOIL NAIL WALL, AT LEAST ONE TEST PIT IN THE ESU #1B SOILS SHALL BE EXCAVATED TO EVALUATE THE UNSUPPORTED WALL FACING STAND—UP TIME. DUE TO THE RESTRICTED ACCESS ON THE SLOPE, TEST PITS WILL BE EXCAVATED PRIOR TO WALL CONSTRUCTION. IF SOIL CONDITIONS VARY FROM THE SOIL PROPERTIES USED IN DESIGN, CONTACT THE DESIGN ENGINEER TO RE—EVALUATE THE WALL DESIGN. OBSERVATION OF THE SOIL CONDITIONS IN THE TEST PITS AND STANDUP DURATION WILL BE A CONSTRUCTION HOLD POINT.

- 2. THE TEST PIT WILL BE CONSTRUCTED AS FOLLOWS:
- a) DEPTH OF TEST PIT SHAL BE AT LEAST TWICE THE VERTICAL NAIL SPACING
- b) LENGTH OF TRENCH BOTTOM SHALL BE AT LEAST ONE AND A HALF TIMES THE EXCAVATION DEPTH
 c) TEST PIT SHALL REAMAIN OPEN AT LEAST 24 HOURS AND SHALL BE MONITORED FOR SLOUGHING, CAVING, AND GROUNDWATER
- d) IF VARIABLE SOIL CONDITIONS ARE PRESENT, A TEST PIT IN EACH SOIL TYPE SHALL BE COMPLETED

SOIL NAIL WALL NOTES SN1
SOIL NAIL WALL PLAN VIEW SN2
SOIL NAIL WALL ELEVATION AND X—SECTIONS SN3
SHEET 1 OF 4
SHEET 2 OF 4
SHEET 3 OF 4

SOIL NAIL WALL DRAWING INDEX

SOIL NAIL WALL DETAILS SN4

SHEET 4 OF 4

the design conforms to the requirments of the RFP and is compliant with the design of the permanent construction. The Engineer of Record for this document is responsible for the design and engineering recommendations provided.

This document was reviewed to ensure

I-405, Renton to Bellevue Widening & and Express Toll Lanes Project

DOCUMENT REVIEW

APPROVED, NO EXCEPTION TAKEN
APPROVED AS NOTED
RESUBMIT, REVISE AS NOTED

REVIEWED BY:

Todd Wentworth
DATE: 6 Jan 22

Geotechnical engineering

Review is for general conformance with contract or design documents. Sole responsibility for correctness of dimensions, details, quantities, materials, and safety during fabrication and erection shall remain with the contractor.

FLATIRON LANE FOR CONSTRUCTION 1/10/2022

REVISION:	DATE:	DESCRIPTION/REASON:	DESIGN BY:	SCALE:
r1	6/21/2021	RESPONSE TO COMMENTS	S. MCNAMARA	AS SHOWN
r2	12/8/2021	UPDATED BASED ON VERIFICATION TESTING	CHECKED BY: K. ARNT	JOB NUMBER: 20018
			DATE: 12/8/2021	DRAWN BY: S. MCNAMARA

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WSDOT I-405 RENTON TO BELLEVUE D/B
WALL 7.15R - TEMPORARY SOIL NAIL SHORING

SHEET:

SHEET

SOIL NAIL WALL NOTES

SN1

-FUTURE PILES BELOW SHORING BOW ELEVATION 7679 7679+50 7680 7681 7680+50 GREEN LINE WORK IS WALL PARALLEL TO TEMP BARRIER

1' OFFSET FROM BACK FACE EXISTING STRUCTURE / ROADWAY -1.5:1 SLOPE DOWN FROM ROADWAY TO WORK ROAD -STA 0 + 00.00PROJ STA. 7679+28 53 ─STA 0+66.23 |TOW| = 69.5BOW = 65.5SOIL NAIL WALL - PLAN VIEW

SCALE AS SHOWN I-405, Renton to Bellevue Widening & and Express Toll Lanes Project DOCUMENT REVIEW APPROVED, NO EXCEPTION TAKEN 1) TSNW LAYOUT LINE (LOL) CAN DEVIATE FROM STRAIGHT LINES ☐ APPROVED AS NOTED This document was reviewed to ensure ☐ RESUBMIT, REVISE AS NOTED SHOWN BY UP TO 2' TO MATCH EXISTING FIELD CONDITIONS. the design conforms to the requirments of the RFP and is compliant with the design of the permanent construction. The Engineer of Record for this document is responsible for the design _ DATE:___6 Jan 22 and engineering recommendations Geotechnical engineering Review is for general conformance with contract or design documents. Sole responsibility for correctness of dimensions, details, quantities, materials, and safety during fabrication and erection shall remain with the contractor. FLATIRON LANE For Construction 1/10/2022 WSDOT I-405 RENTON TO BELLEVUE D/B REVISION: DATE: DESCRIPTION/REASON: DESIGN BY: SCALE: SHEET: AS SHOWN S. MCNAMARA 6/21/2021 RESPONSE TO COMMENTS THE USE OF THESE DRAWINGS AND WALL 7.15R - TEMPORARY SOIL NAIL SHORING SPECIFICATIONS SHALL BE RESTRICTED TO THE ORIGINAL USE FOR WHICH THEY WERE PREPARED. REUSE, REPRODUCTION, OR DISTRIBUTION, IN WHOLE OR IN PART, IS PROHIBITED WITHOUT THE WRITTEN CONSENT OF DRILL TECH DRILLING & SHORING, INC. UPDATED BASED ON VERIFICATION TESTING CHECKED BY: JOB NUMBER: 12/8/2021 DRILLING & SHORING, INC.

355 N. Sheridan St. Suite 117 — Corona, CA 92880

Phone: 951/277-9700 - Fax: 951/277-9701

SHORING ELEVATIONS AND X-SECTIONS

20018


DRAWN BY:

S. MCNAMARA

K. ARNT

12/8/2021

DATE:

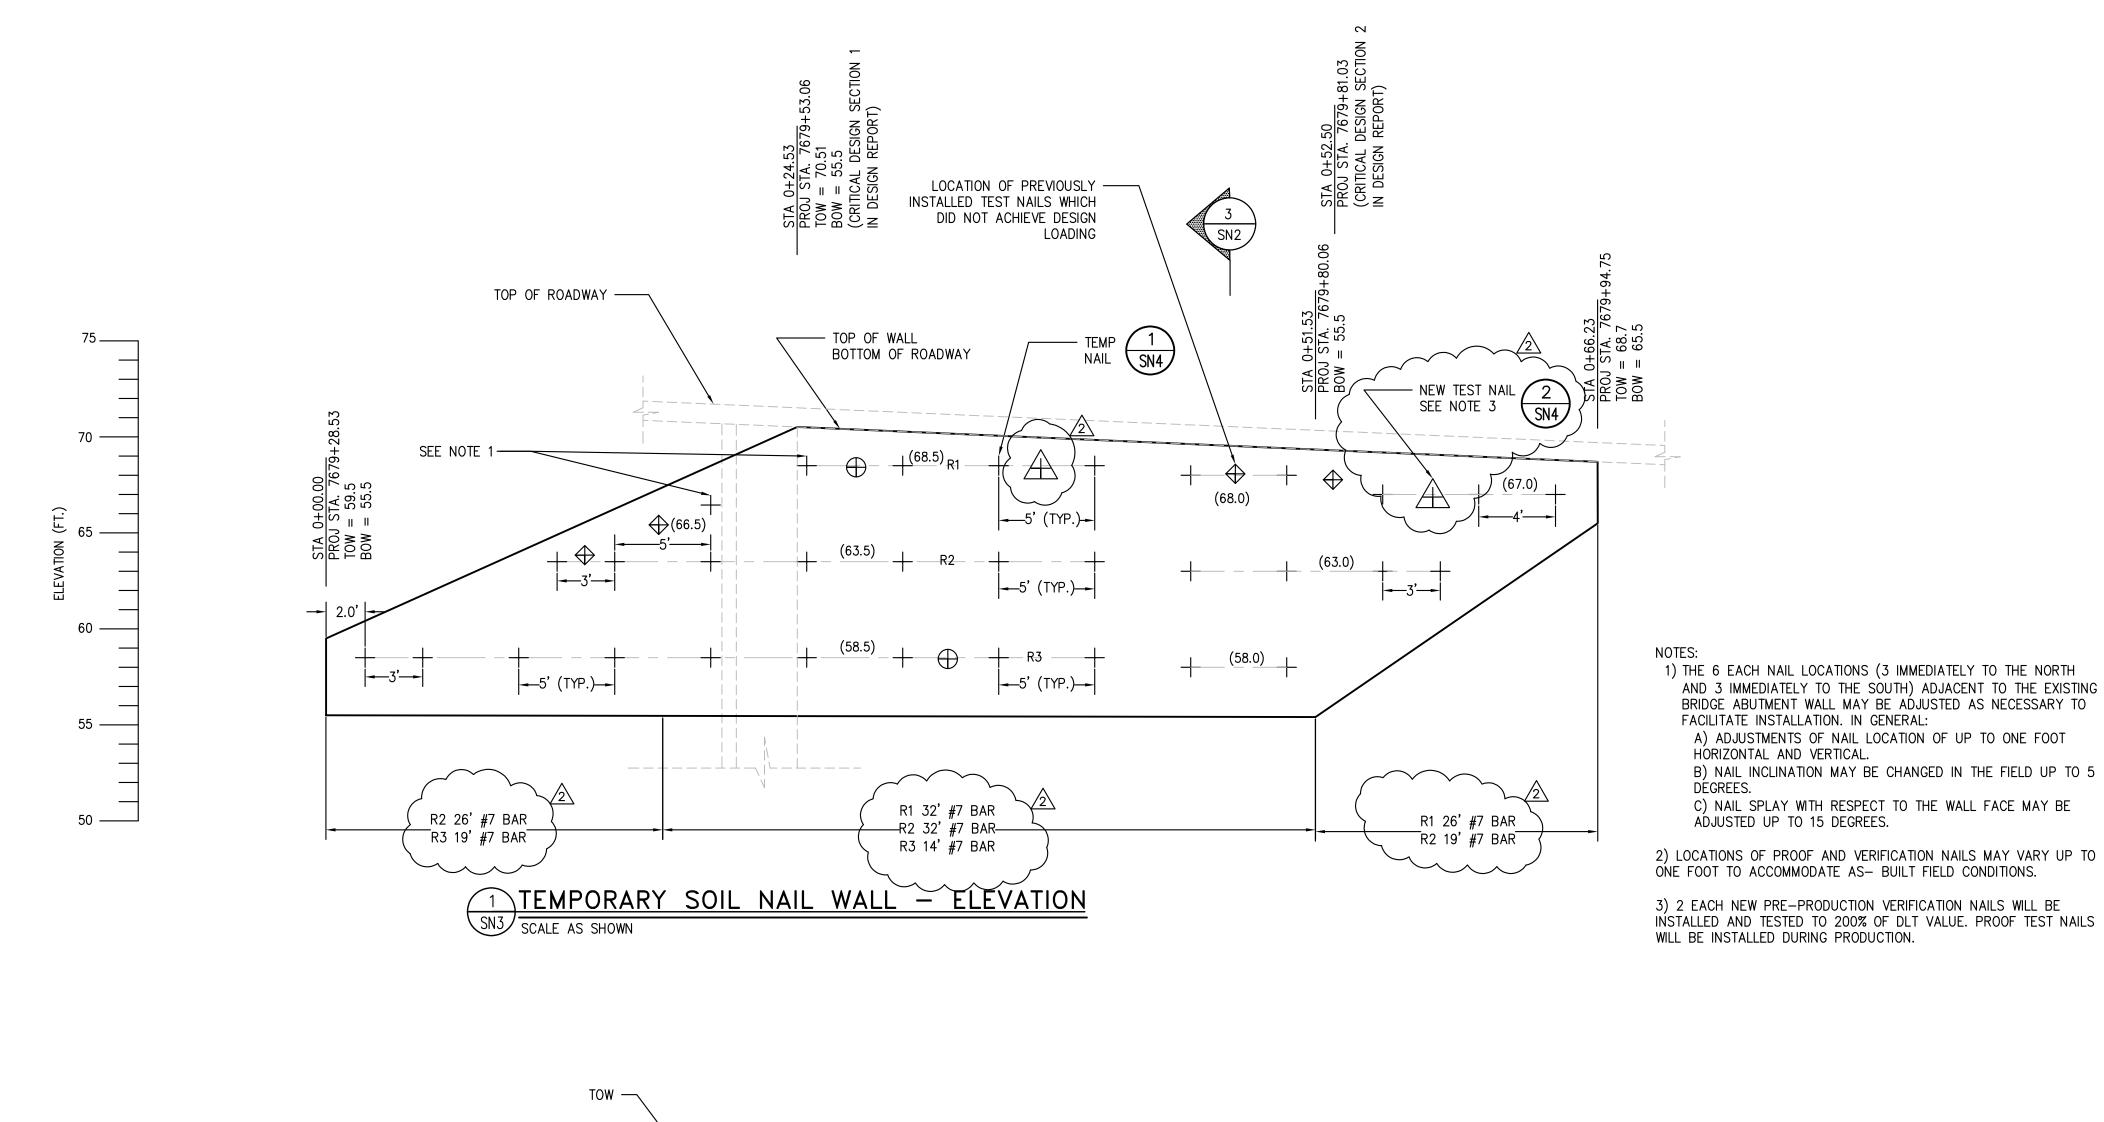

I-405, Renton to Bellevue Widening & and Express Toll Lanes Project

DOCUMENT REVIEW

APPROVED, NO EXCEPTION TAKEN
APPROVED AS NOTED
RESUBMIT, REVISE AS NOTED

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REVIEWED BY: Todd Wentworth DATE: 6 Jan 22

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FLATIRON LANE FOR CONSTRUCTION 1/10/2022

SOIL NAIL WALL - TYPICAL CROSS SECTION
SCALE AS SHOWN

+ TEMPORARY SOIL NAIL
A NEW VERIFICATION TEST SOIL NAIL
⊕ PROOF TEST SOIL NAIL
♦ PREVIOUSLY DESIGN TEST NAILS
STA. WALL STATIONING
TOW TOP OF WALL
BOW BOTTOM OF WALL
FG FINISHED GRADE
(XX.XX) NAIL ELEVATION
0 2.5 5 10 1
SCALE: 1" = 5'

LEGEND

REVISION:	DATE:	DESCRIPTION/REASON:	DESIGN BY:	SCALE:
r1	6/21/2021	RESPONSE TO COMMENTS	S. MCNAMARA	AS SHOWN
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WSDOT 1-405 RENTON TO BELLEVUE D/

WALL 7.15R - TEMPORARY SOIL NAIL SHORING

SHEET:

SHORING ELEVATIONS AND X-SECTIONS

SHEET C

